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 Tree types and sizes should be treated with a degree of caution. Trees with a trunk diameter of more than 0.15 m have been recorded. Areas of dense vegetation shown in outline only.
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Legend:

Spot Height Station Gate Fence Line

Overhead Wire

Revisions

By Comment 18.10.17 CH First Issue

A 29.01.18 CH Boundaries Surveyed (See Revision Clouds)


Control Stations:

Name:	SS001	Name:	SS004
Easting:	594614.731	Easting:	594597.891
Northing:	187521.864	Northing:	187491.572
Elevation:	5.838	Elevation:	6.450
Type:	MAG Nail	Type:	MAG Nail
Name:	SS002	Name:	SS005
Easting:	594583.248	Easting:	594623.058
Northing:	187513.991	Northing:	187492.296
Elevation:	6.057	Elevation:	6.583
Type:	MAG Nail	Type:	MAG Nail
Name: Easting: Northing: Elevation: Type:	SS003 594576.701 187504.220 6.099 MAG Nail		

Topographical Key:

Topographical Key:

BOL = Bollard
CH = Chimney
FP = Flag Pole
GT = Gate
IC = Inspection Chambe
KRB = Kerb
LP = Lamp Post
SC = Scaffolding
TP = Telegraph Pole
VEG = Vegetation Outline
WAT = Water Meter/IC
WL = Wall

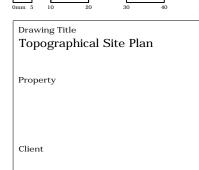


Job Reference	Drawing No	Revision
1804	001	A
Status Information	Only	
Drawn by	Surveyed CH	by
Scale As Shown	Original A3	Size



A: THS Concepts LTD / 92 Bellhouse Land Leigh-on-Sea / Essex / SS9 4PQ

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- channel.

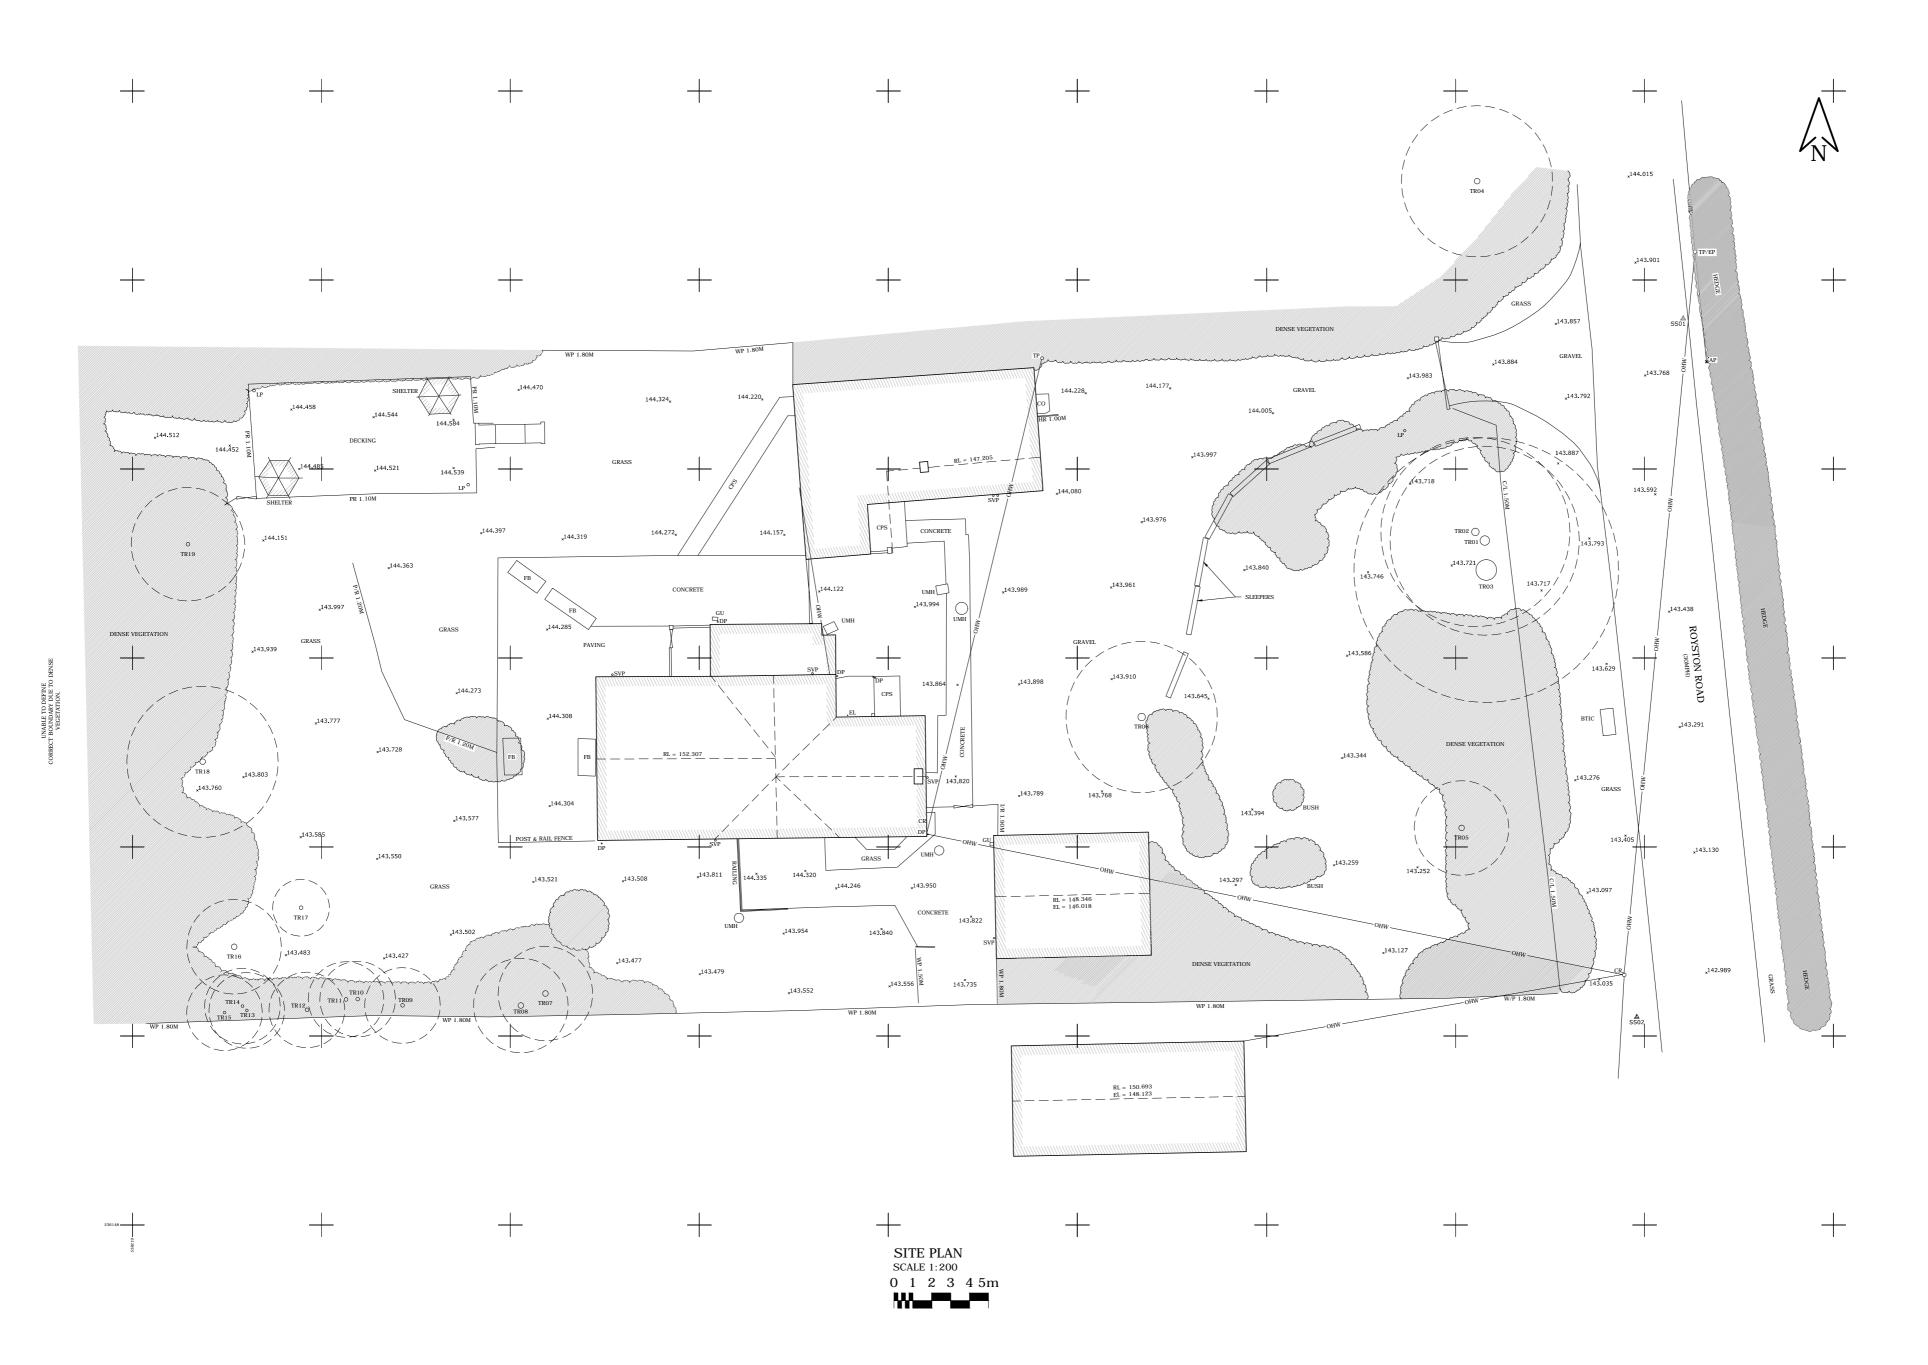
 GPS surveys are based on co-ordinates to OSGB36 to system file OSGB36 (15).

Control Stations:

Name:	SS01	Name:	SS02	
Easting:	538301.043	Easting:	538298.587	
Northing:	236195.959	Northing:	236159.000	
Elevation:	143.771	Elevation:	144.717	
Type:	MAG Nail	Type:	MAG Nail	

Tree Schedule:

Tree_No	Spread_Radius	Trunk_Diameter	Height
TR01	5.000	0.500	14.00
TR02	5.000	0.400	14.00
TR03	7.000	1.100	14.00
TR04	4.000	0.300	10.00
TR05	2.500	0.300	14.00
TR06	4.000	0.400	8.00
TR07	2.500	0.300	9.00
TR08	2.500	0.300	9.00
TR09	2.000	0.200	8.00
TR10	2.000	0.200	8.00
TR11	2.000	0.200	8.00
TR12	2.000	0.200	8.00
TR13	2.000	0.150	8.00
TR14	2.000	0.150	8.00
TR15	2.000	0.150	8.00
TR16	2.500	0.300	8.00
TR17	1.500	0.200	7.00
TR18	4.000	0.300	8.00
TR19	3.000	0.200	10.00

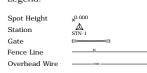

Topographical Key:

Topographical Key:

BTIC = BT Inspection Chamber
SS = Survey Station
AP = Anchor Point
OHW = Over Head Wire
GU = Gully
DP = Down Pipe
SVP = Soil Vent Pipe
EL = Eaves Level
CPS = Concrete Paving Slabs
WP = Wooden Panel Fencing
C/L = Chain Link Fencing
RL = Ridge Level
P/R = Post And Rail Fencing
HR = Hand Rail

HR = Hand Rail
CR = Cable Rise
FB = Flower Bed
TP = Telegraph Pole
EP = Electric Pole

No. Date By Comment 13.11.17 SW First Issue



Client


	Job Reference	Drawing No	Revision
	1827	001	_
- 1			

Information Only

Drawn by Surveyed by SW SW Scale Original Size As Shown A2



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Legend:

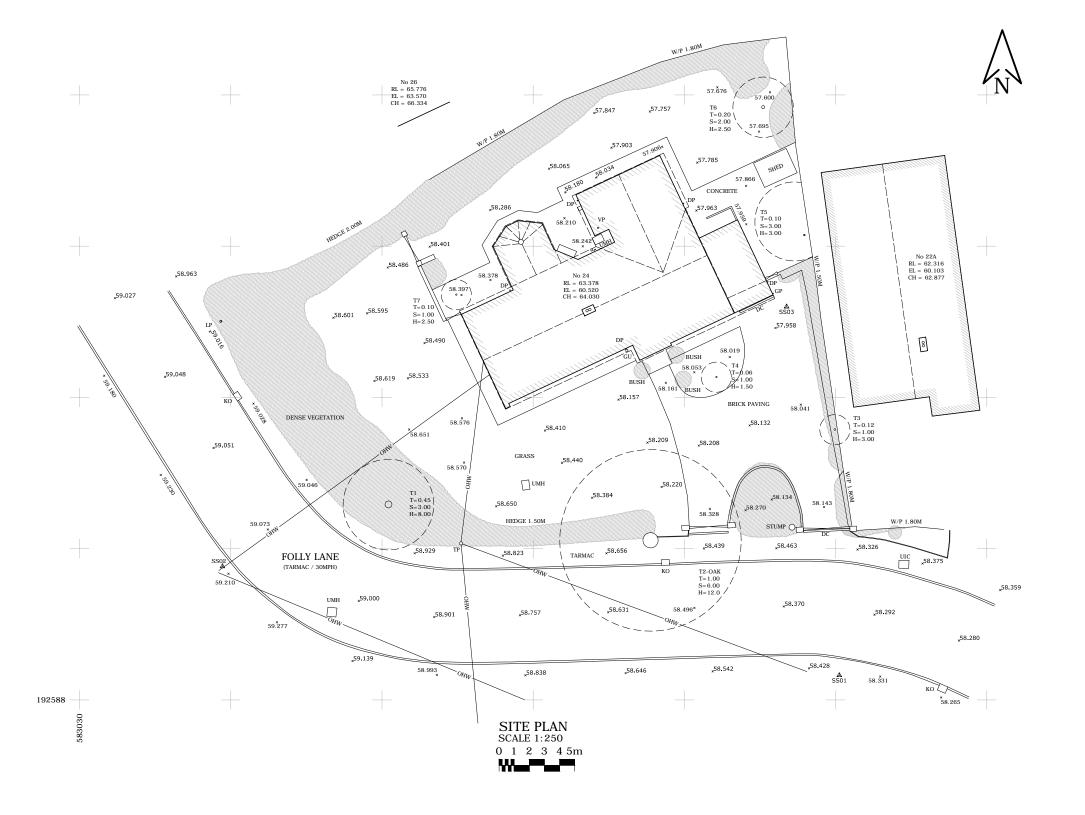Spot Height Station Gate Fence Line

Overhead Wire

Revisions

Date By Comment 02.02.18 SW First Issue

Control Stations:

SS02 583039.450 Easting: 583080.251
Northing: 192589.627
Elevation: 58.407
Type: Mag Nail Easting: 583039.450
Northing: 192596.823
Elevation: 59.199
Type: Mag Nail


SS03 Easting: 583076.761 Northing: 192613.991 Elevation: 57.947 Mag Nail Type:

Topographical Key:

= Chimney Height CH DC DP EL GU KO LP = Drainage Channel = Down Pipe = Eaves Level = Gully = Kerb Outlet LP = Lamp Post OHW = Overhead Wire

RL = Ridge Height SS = Survey Station TP = Telegraph Pole

TP = Telegraph Pole
UIC = Unknown Inspection Chamber
UMH = Unknown Manhole
VP = Vent Pipe
W/P = Wooden Panel Fencing

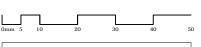

Drawing Title Topographical Site Plan

Property

Client

Job Reference	Drawing No	Revision
1884	001	ı


Status **Information Only**

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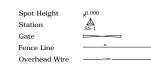
- channel.

 GPS surveys are based on co-ordinates to OSGB36 to system file OSGB36 (15).

Control Stations:

Name:	SS01	Name:	SS03
Easting:	583759.991	Easting:	583735.3
Northing:	188208.991	Northing:	188249.2
Elevation:	38.511	Elevation:	37.564
Type:	Mag Nail	Type:	Mag Nail
Name:	SS02	Name:	SS04
Easting:	583766.757	Easting:	583745.2
Northing:	188192.121	Northing:	188186.7
Elevation:	38.727	Elevation:	39.732

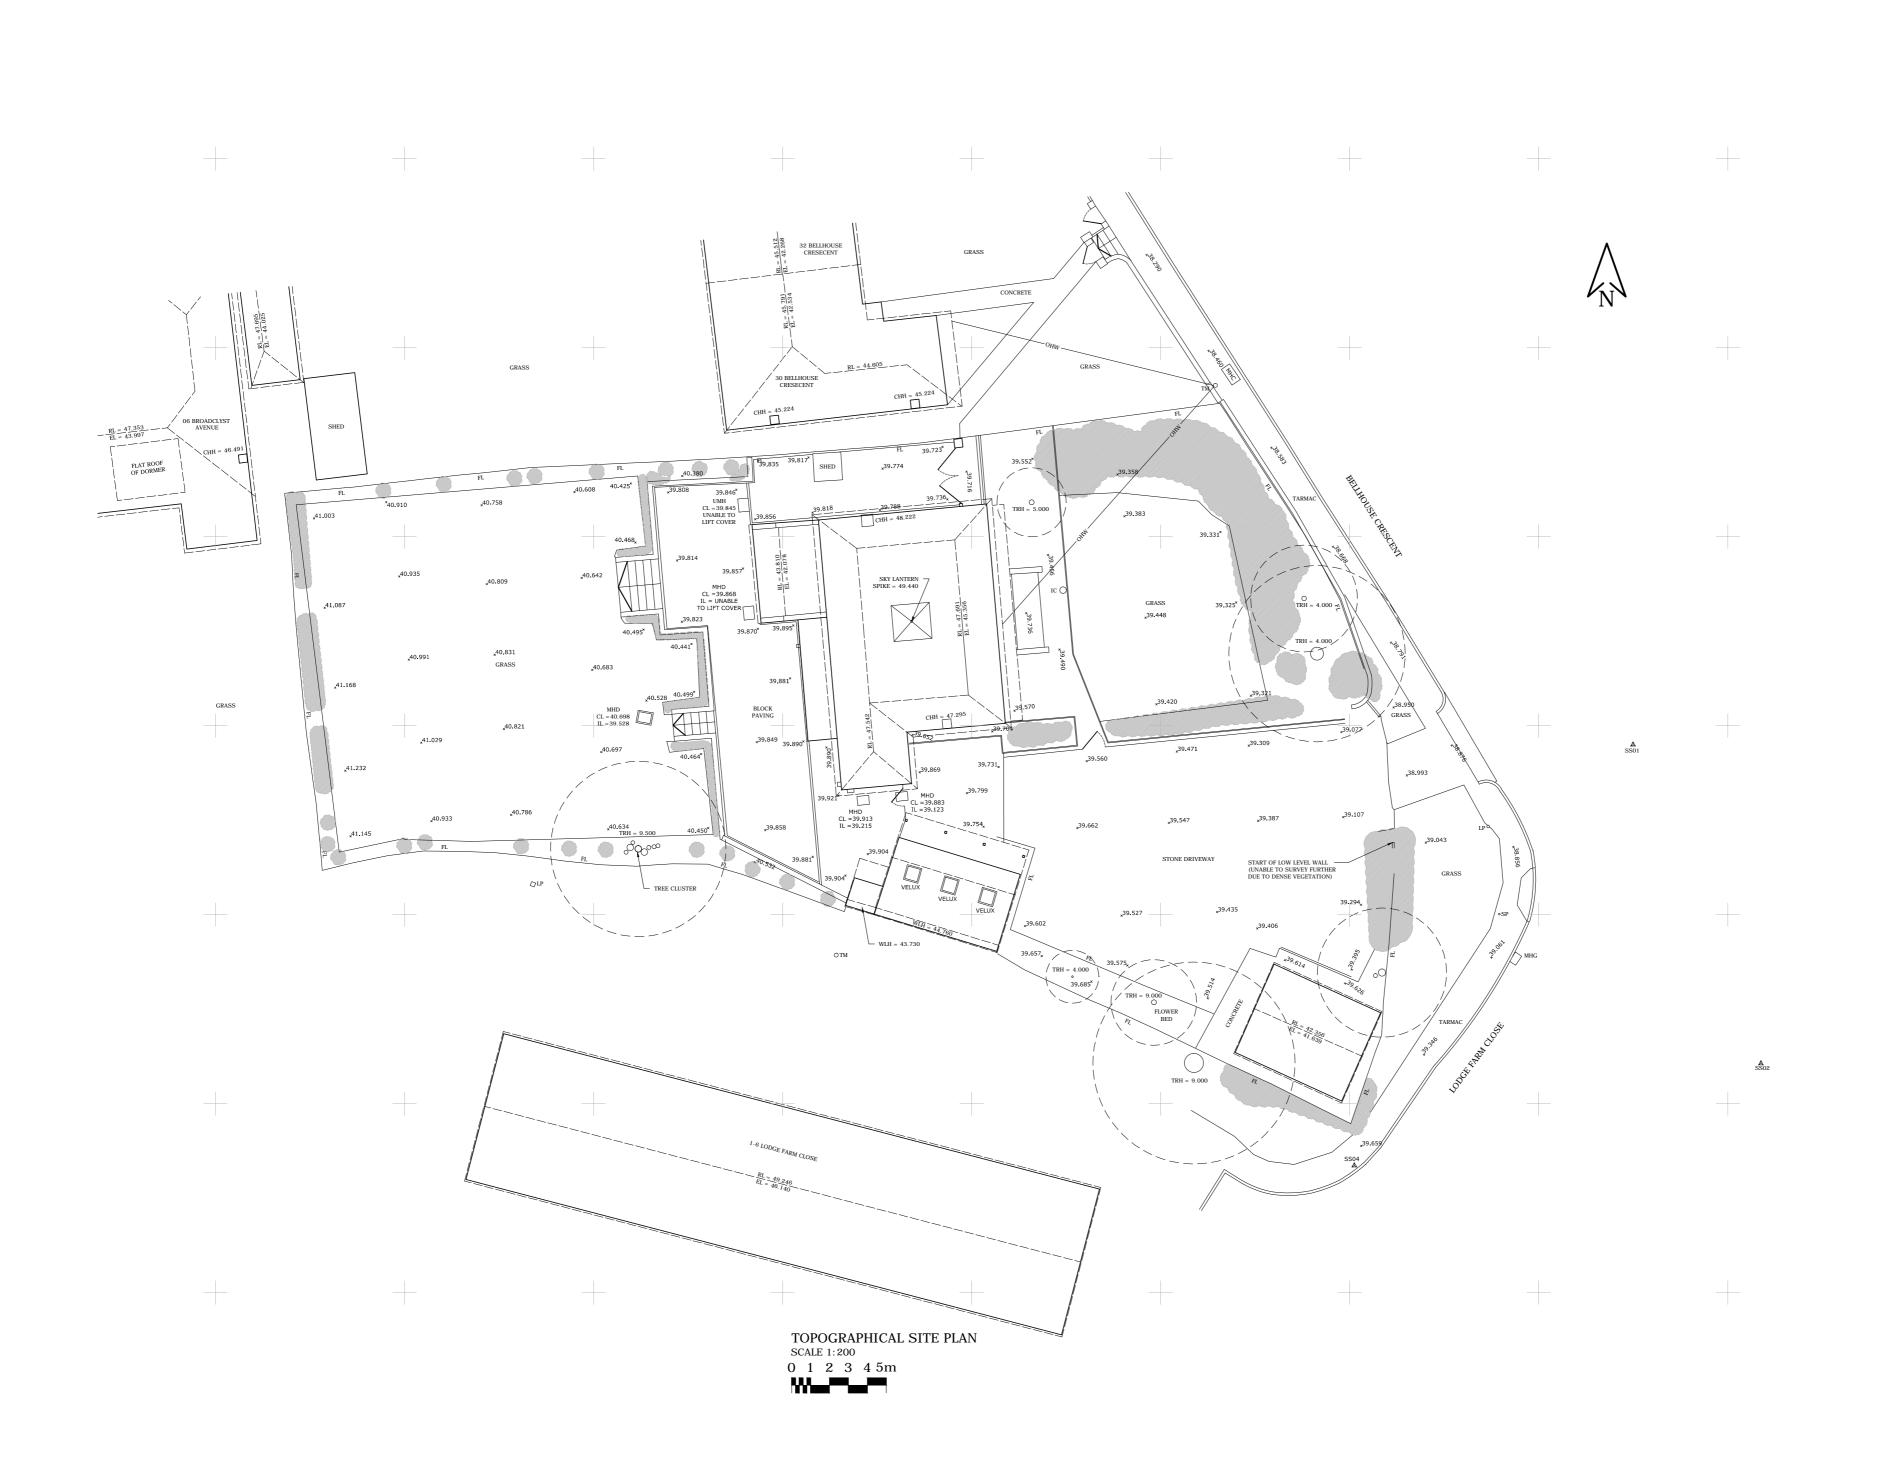Legend:



Tence Line	
Overhead Wire	OHW-
Topographica	ıl Key:
CUU _ Chimnes	

- CHH = Chimney Height
 EL = Eaves Level
 FL = Fence Line
 IC = Inspection Chamber
 LP = Lamp Post
 MHC = Communications Manhole
 MHD = Drainage Manhole
 MHG = Road Gulley
 RL = Ridge Level
 SP = Sign Post
 TM = Telephone Mast

No. Date By Comment
- 06.02.18 JB First Issue

Drawing Title Topographical Site Plan

Client

Job Reference	Drawing No	Revision
1885	001	_
Status		

As Shown

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A2



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Control Stations:

 Name:
 SS01
 Name:
 SS02

 Easting:
 552974.500
 Easting:
 553009.229

 Northing:
 214966.302
 Northing:
 214986.108

 Elevation:
 79.166
 Elevation:
 78.764

 Type:
 MAG Nail
 Type:
 MAG Nail

Tree No.	Spread Rad.	Trunk Dia.	Не
TR01	5.000	1.400	15
TR02	3.000	0.160	8
TR03 TR04	3.000 4.000	0.180 0.350	9
TR05	1.000	0.100	3
TR06	3.000	0.450	12
TR07	3.000	0.300	7
TR08	2.000	0.100	3
TR09 TR10	4.000 1.500	0.300 0.100	10
TR11	2.000	0.100	4
TR12	0.500	0.100	4
TR13	2.000	0.150	7
TR14	3.000	0.200	8
TR15	5.000	0.600	10
TR16 TR17	3.000	0.300	1:
TR18	3.500	0.250	8
TR19	1.500	0.200	4
TR20	2.000	0.700	13
TR21	1.500	0.250	12
TR22 TR23	2.500	0.140	10
TR24	1.500 2.000	0.600	4
TR25	1.500	0.250	10
TR26	1.500	0.200	1
TR27	2.000	0.100	4
TR28	2.000	0.350	1
TR29 TR30	6.000 2.600	1.500 0.150	1 -
TR31	1.200	0.100	2
TR32	2.000	0.100	4
TR33	3.500	0.300	1
TR34	5.000	0.700	1
TR35	2.000	0.100	8
TR36 TR37	1.500 2.000	0.120	- 4
TR38	1.000	0.100	1
TR39	1.000	0.200	1
TR40	2.000	0.100	1
TR41	0.400	0.040	2
TR42 TR43	1.500 3.000	0.250 0.250	1
TR44	4.000	0.400	1
TR45	1.500	0.100	4
TR46	1.500	0.200	
TR47	1.500	0.120	
TR48 TR49	1.500 2.000	0.150 0.060	
TR50	2.500	0.150	5
TR51	5.000	0.400	7
TR52	2.000	0.100	5
TR53	1.000	0.100	. 5
TR54 TR55	2.000 3.000	0.100 0.120	- 5 - 6
TR56	1.000	0.050	3
TR57	1.500	0.060	3
TR58	1.500	0.100	ϵ
TR59	1.500	0.120	ϵ
TR60	3.000	0.280	7
TR61 TR62	2.500 1.000	0.250 0.150	2
TR63	3.000	0.150	6
TR64	1.000	0.080	3
TR65	3.000	0.250	7
TR66	1.000	0.100	4
TR67	1.200	0.120	
TR68	1.200	0.120	5
TR69	1.000	0.120	4
TR71	1.500	0.100	3
TR72	3.000	0.130	8
TR73	4.000	0.250	8

Fence Line

Overhead Wire ------Topographical Key:

Topographical Key:

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CHH = Chimney Height
CL = Chain Link Fencing
DP = Down Pipe
EL = Eaves Level
EP = Electric Pole
FB = Flower Bed
GU = Gully
OHW = Overhead Wire
PR = Post and Rail Fencing
PW = Post and Wire Fencing
RL = Ridge Level
SS = Survey Station
SVP = Soil Vent Pipe
TR = Tree
UIC = Unknown Inspection Chi
UMH = Unknown Inspection Chi
UMH = Unknown Tree Type
VP = Vent Pipe
WM = Water Meter
WP = Wooden Panel Fencing

No. Date By Comment 23.02.18 SW First Issue

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SW

Original Size

Drawn by **SW**

Scale As Shown

